

BEFORE THE ILLINOIS POLLUTION CONTROL BOARD

NextGen Agriculture, LLP)
(Property Identification Number) PCB 17-
12-12-100-004) (Tax Certification)
)

NOTICE

Steve Santarelli
Illinois Department of Revenue
101 West Jefferson
Post Office Box 19033
Springfield, Illinois 62794

John Theirrault, Clerk
Illinois Pollution Control Board
James R. Thompson Center
100 West Randolph Street, Suite 11-500
Chicago, Illinois 60601

Taylor Wildermuth
13126 US HWY 6
Geneseo, Illinois 61274

PLEASE TAKE NOTICE that I have today filed with the Office of the Clerk of the Pollution Control Board an **APPEARANCE** and **RECOMMENDATION OF THE ILLINOIS ENVIRONMENTAL PROTECTION AGENCY**, a copy of which is herewith served upon you.

ILLINOIS ENVIRONMENTAL PROTECTION AGENCY

By: 
Vera Herst
Assistant Counsel
Division of Legal Counsel

DATED: September 27, 2016

Illinois Environmental Protection Agency
1021 North Grand Avenue East
Post Office Box 19276
Springfield, Illinois 62794-9276
(217) 782-5544

THIS FILING IS SUBMITTED ON RECYCLED PAPER


BEFORE THE ILLINOIS POLLUTION CONTROL BOARD

NextGen Agriculture, LLP)
(Property Identification Number) PCB 17-
12-12-100-004)) (Tax Certification)
)

APPEARANCE

The undersigned, as one of its attorneys, hereby enters an APPEARANCE on behalf of Respondent, Illinois Environmental Protection Agency.

ILLINOIS ENVIRONMENTAL PROTECTION AGENCY

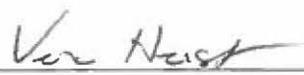By: 
 Vera Herst
 Assistant Counsel
 Division of Legal Counsel

DATED: September 27, 2016

Illinois Environmental Protection Agency
 1021 North Grand Avenue East
 Post Office Box 19276
 Springfield, Illinois 62794-9276
 (217)782-5544

BEFORE THE ILLINOIS POLLUTION CONTROL BOARD

NextGen Agriculture, LLP)
(Property Identification Number) PCB 17-
12-12-100-004) (Tax Certification)
)

RECOMMENDATION OF THE ILLINOIS ENVIRONMENTAL PROTECTION AGENCY

The Illinois Environmental Protection Agency ("Illinois EPA") hereby files its Recommendation pursuant to Section 125.204 of the regulations of the Illinois Pollution Control Board ("Board"), 35 Ill. Adm. Code 125.204.

1. On December 10, 2015, the Illinois EPA received a request from NextGen Agriculture, LLP (log number TC-31-15, Exhibit A) for an Illinois EPA recommendation regarding the tax certification of water pollution control facilities pursuant to 35 Ill. Adm. Code 125.204.
2. The facility's address is: NextGen Agriculture, LLP
11343 N. 1700 Ave.
Osco, IL 61274

The proposed water pollution control facilities in this request are located in the NW ¼ of Section 12, T16N, R2E of the 4th P.M. in Henry County, at the above street address and consist of the following:

Livestock waste handling facilities consisting of one (1) concrete manure pit (approximately 265 ft. x 71 ft. x 8 ft.) and the concrete slat portion of the floor over the manure pit that capture and contain waste generated in the barn above. The pit has six (6) (approximately 6 ft. x 6 ft. x 8 ft. each) pump out pits to allow manure removal from the manure pit. A perimeter drainage tile is located around the footing of the pit to prevent floatation of the manure pit.

These livestock waste management facilities are used to collect, transport and/or store livestock waste prior to cropland application, and are further described in Exhibit A.

3. Section 11-10 of the Property Tax Code, 35 ILCS 200/11-10 (2014), and Section 125.200(a) of the Board's regulations, 35 Ill. Adm. Code 125.200(a), define

"pollution control facilities" as:

any system, method, construction, device or appliance appurtenant thereto or any portion of any building or equipment, that is designed, constructed, installed or operated for the primary purpose of: eliminating, preventing, or reducing air or water pollution ...or treating, pretreating, modifying or disposing of any potential solid, liquid or gaseous pollutant which if released without treatment, pretreatment modification or disposal might be harmful, detrimental or offensive to human, plant or animal life, or to property.

4. In order to receive preferential tax treatment as pursuant to 35 ILCS 200/11-5 (2014), pollution control facilities must be certified as such by the Board, 35 ILCS 200/11-20 (2014) and 35 Ill. Adm. Code 125.200(a).
5. Upon receipt of a tax certification application, the Illinois EPA must file a recommendation on the application with the Board, 35 Ill Adm. Code 125.204(a).
6. Based on the information in the application and the purpose of the facility, it is the Illinois EPA's engineering judgment that the described facilities may be considered "pollution control facilities," pursuant to 35 Ill. Adm. Code 125.200(a), with the primary purpose of eliminating, preventing, or reducing water pollution, or as otherwise provided in 35 Ill. Adm. Code 125.200, and are eligible for tax certification from the Board.

WHEREFORE, the Illinois EPA recommends that the Board issue the requested tax certification.

ILLINOIS ENVIRONMENTAL PROTECTION AGENCY

By: 
Vera Herst
Assistant Counsel
Division of Legal Counsel

Dated: September 27, 2016

Illinois Environmental Protection Agency
1021 North Grand Ave. E.
P.O. Box 19276
Springfield, Illinois 62794-9276
217/782-5544



ILLINOIS ENVIRONMENTAL PROTECTION AGENCY

1021 NORTH GRAND AVENUE EAST, P.O. BOX 19276, SPRINGFIELD, ILLINOIS 62794-9276 • (217) 782-3397

BRUCE RAUNER, GOVERNOR

ALEC MESSINA, ACTING DIRECTOR

Memorandum

To: Charles Gunnarson, Division of Legal Counsel
From: Al Keller, Manager, Permit Section *AK*
Date: September 6, 2016
Re: NextGen Agriculture, LLP (Taylor Wildermuth Site) – Osco
Recommendation of Tax Certification
Log # TC-31-15
Property Identification # 12-12-100-004

The Bureau of Water received a request on December 10, 2015 from Taylor Wildermuth for an Illinois EPA recommendation regarding the tax certification of water pollution control facilities pursuant to 35 Ill. Adm. Code 125.204. We offer the following recommendation.

The water pollution control facilities in this request include the following:

NextGen Agriculture, LLP (Taylor Wildermuth Site)
11343 N 1700 Ave.
Osco, IL 61274

NW ¼ of Section 12, T16N, R2E of the 4th PM in Henry County.

The livestock waste handling facilities consist of one (1) concrete manure pit (approximately 265 ft. x 71 ft. x 8 ft.) and the concrete slat portion of the floor over the manure pit that capture and contain waste generated in the barn above. The pit has six (6) (approximately 6 ft. x 6 ft. x 8 ft. each) pumpout pits to allow manure removal from the manure pit. A perimeter drainage tile is located around the footing of the pit to prevent flotation of the manure pit. These facilities collect, transport and store livestock waste prior to cropland application.

The facility is further described in the enclosed applications and supporting documents.

Based on the information included in this submittal, it is our engineering judgment that the above proposed facilities may be considered "Pollution Control Facilities" under 35 IAC 125.200(a), with the primary purpose of eliminating, preventing, or reducing water pollution, or as otherwise provided in this section, and therefore eligible for tax certification from the Illinois Pollution Control Board. The Bureau of Water therefore recommends that the Board issue the requested tax certification for these facilities.

If you have any questions regarding the above, please contact Wei Han at 217/782-0610.

SAK:WH:Tax Cert Recommendation.docx

cc: Tax Cert File

Watershed Unit Tax Certification Review Sheet

Project Name: NextGen Agriculture, LLP – Taylor Wildermuth Site

Date Control Devices installed: 11/20/2015

Reviewer: WH

Location: Geneseo, IL

Log number: TC-31-15

Date: August 10, 2016

Type: Agchem
 Livestock

Applicant: Taylor Wildermuth
13126 US HWY 6
Geneseo, IL 61254
Phone: 309-714-8977

Contact: Mitch Baum
2304 Lakeview Dr.
Ames, IA 50010
Phone: 641-373-4242

Facility: Taylor Wildermuth Farm
11343 N 1700 Ave.
Osco, IL 61274

Parcel ID: 12-12-100-004

County: Henry

Legal Description:
NW ¼ of Section:12 Twp: 16N R: 2E PM: 4th

Signature: Taylor Wildermuth

Title: Owner

- Wastes:
- Livestock waste is applied to cropland.
 - Agrichemical rinsate and spillage is recycled through the facility and/or land applied.
 - Other: _____

Physical Description of Pollution Control Devices:

The livestock waste handling facilities consist of one (1) concrete manure pit (approximately 265 ft. x 71 ft. x 8 ft.) and the concrete slat portion of the floor over the manure pit that capture and contain waste generated in the barn above. The pit has six (6) (approximately 6 ft. x 6 ft. x 8 ft. each) pumpout pits to allow manure removal from the manure pit. A perimeter drainage tile is located around the footing of the pit to prevent floatation of the manure pit. The facility collects, transports and stores livestock waste prior to cropland application.

08/08/2016: The application indicated that pollution control facility is the entire barn. Called Mitch Baum about the correction of pollution control facility description. Also sent him email for him to provide the corrections by email.

09/09/2016: Mitch Baum emailed revised Attached #1 and #2. The pollution control facility only includes the underfloor storage pit and the concrete floor above it.

Recommended Action: Issue tax certification.



1021 North Grand Avenue East • P.O. Box 19276 • Springfield • Illinois • 62794-9276

**Application for Certification (Property Tax Treatment)
Pollution Control Facility**

FOR AGENCY USE ONLY

File Number: _____ Date Rec'd: _____
Certification Number: _____ Date: _____

Facility Type (check one): Air Water

This form is to be used for any application for certification of property tax treatment for a pollution control facility for air or water from the Illinois EPA. Separate applications must be completed for each control facility claimed. Do not mix types (air and water). Where both air and water operations are related, file two applications.

If attachments are needed, record them consecutively on an index sheet.

You may complete this form online, save a copy locally, print, sign and submit it to:

Illinois EPA
Attention: Al Keller, Permit Section
Division of Water Pollution Control
1021 North Grand Avenue East, P.O. Box 19276
Springfield, IL 62794-9276

RECEIVED
DEC 10 2015
1511
DOW/WPC/PERMIT SECTION

I. Applicant Information:

Company Name: NEXTGEN AGRICULTURE LLP (TAYLOR WILDERMUTH SITE)
Person Authorized to Receive Certification: TAYLOR WILDERMUTH Person to Contact for Additional Details: MITCH BAUM
Street Address: 13126 US HWY 6 Street Address: 2304 LAKEVIEW DR
City: GENESEO State: IL City: AMES State: IA
Zip: 61254 Phone: 309-714-8977 Zip: 50010 Phone: 641-373-4242
Email Address: TAWILDERMUTH@GMAIL.COM Email Address: MITCH@BAUMFARMS.COM

II. Facility Information:

Facility Location: Quarter Section: NW Township: 16N Range: 2E
Municipality: GENESEO Township: OSCO
Note: A plat map location is requested for facilities located outside of municipal boundaries.
Address: 11343 N1700 AVE City: OSCO
State: IL Zip Code: 61274 County: Henry Book Number: _____
Property Index Number: 12-12-100-002

Note: The Property Index Number is the numerical reference used to identify a parcel of real property for assessment and taxation purposes.

Manufacturing Operations Information:

Nature of Operations Conducted at the Above Location:

SWINE CONFINEMENT FINISHER

Permit Information:

WPC Construction Permit Number: _____ Date Issued: _____
NPDES Permit Number: ILR10V511 Date Issued: Aug 5, 2015 Exp. Date: _____
APC Construction Permit Number: LF073047 Date Issued: Aug 3, 2015
APC Operating Permit Number: _____ Date Issued: _____ Exp. Date: _____

Note: Submit copies of all relevant permits issued by local pollution control agencies. (e.g. MSD Construction Permit)

This Agency is authorized to request this information under 415 ILCS 5/4(b)(2012). Disclosure of this information is voluntary and no penalties will result from the failure to provide the information. However, the absence of the information could prevent your application from being processed or could result in denial of your application.

Point(s) of Waste Water Discharge:

Identify the location of the discharge to the receiving stream. This will typically refer to a source of water pollution but can include water-carried wastes from air pollution control facilities.

Plans and Specifications Attached Yes No

Submit Drawings, which clearly show:

- (a) Point(s) of discharge to receiving stream; and
- (b) Sewers and process piping to and from the control facility.

Are contaminants (or residues) collected by the control facility? Yes No

Note: If the collected contaminants are disposed of other than as wastes, state the disposition of the materials, and the value dollars reclaimed by the sale or reuse of the collected substances. State the cost of reclamation and related expense.

Project Status:

Date Installation Completed: Nov 20, 2015

Provide the date the pollution control facility was first placed into service and operated. If not, explain.

SWINE CONFINEMENT FACILITY WAS PLACED IN SERVICE ON 11/30/15.

Status of installation on date of application:

COMPLETE

III. Verification and Signature:

The following information is submitted in accordance with the Illinois Property Tax Code, as amended, and to the best of my knowledge is true and correct.

Any person who knowingly makes a false, fictitious, or fraudulent material statement, orally or in writing, to the Illinois EPA commits a Class 4 felony. A second or subsequent offense after conviction is a Class 3 felony. (415 ILCS 5/44(h))

Taylor Wildermuth
Printed Name:


Co-owner
Title:

For incorporated entities, signature should be from an authorized corporate representative.


Taylor Wildermuth
Signature:

12/7/15
Date:

CONSTRUCTION PLANS FOR
TAYLOR WILDERMUTH
 HENRY COUNTY, ILLINOIS

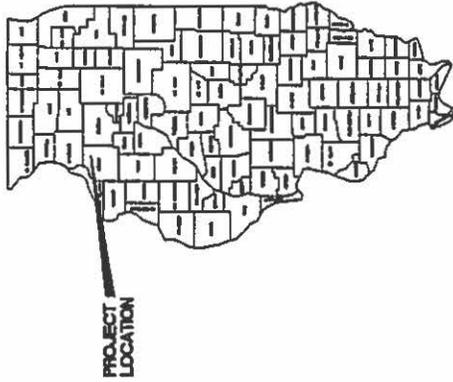

PROJECT SITE

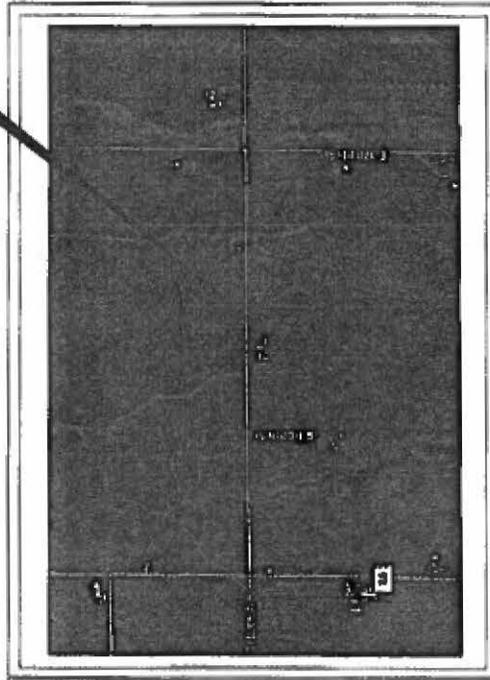

INDEX TO SHEETS

SHEET NO.	DESCRIPTION
C101	CORNER SHEET
C102	FARMSTEAD PLAN
C103	SITE PLAN
C201	FOUNDING PLAN
C202	FOUNDING DETAILS
S101	PIV PLAN 100'
S201	PIV SECTIONS
S301	PIV WALL AND CELLAR DETAILS
S401	TYPICAL CONCRETE DETAILS
S501	PRECAST FLOOR JOISTS
S701	



ROBERT L. STUTZ, P.E.
 No. 11749
 State of Illinois
 EXPIRES 11/28/2018
 PHOTO COURTESY OF THE ILLINOIS STATE BOARD OF SURVEYORS



HENRY J. JOHNSON, P.E.
 No. 11749
 State of Illinois
 EXPIRES 11/28/2018
 PHOTO COURTESY OF THE ILLINOIS STATE BOARD OF SURVEYORS




PLANS PREPARED BY:



MSI PROJECT NO. 2385018.02

RECEIVED
 DEC 10 2015
 ILLINOIS PERMIT SECTION

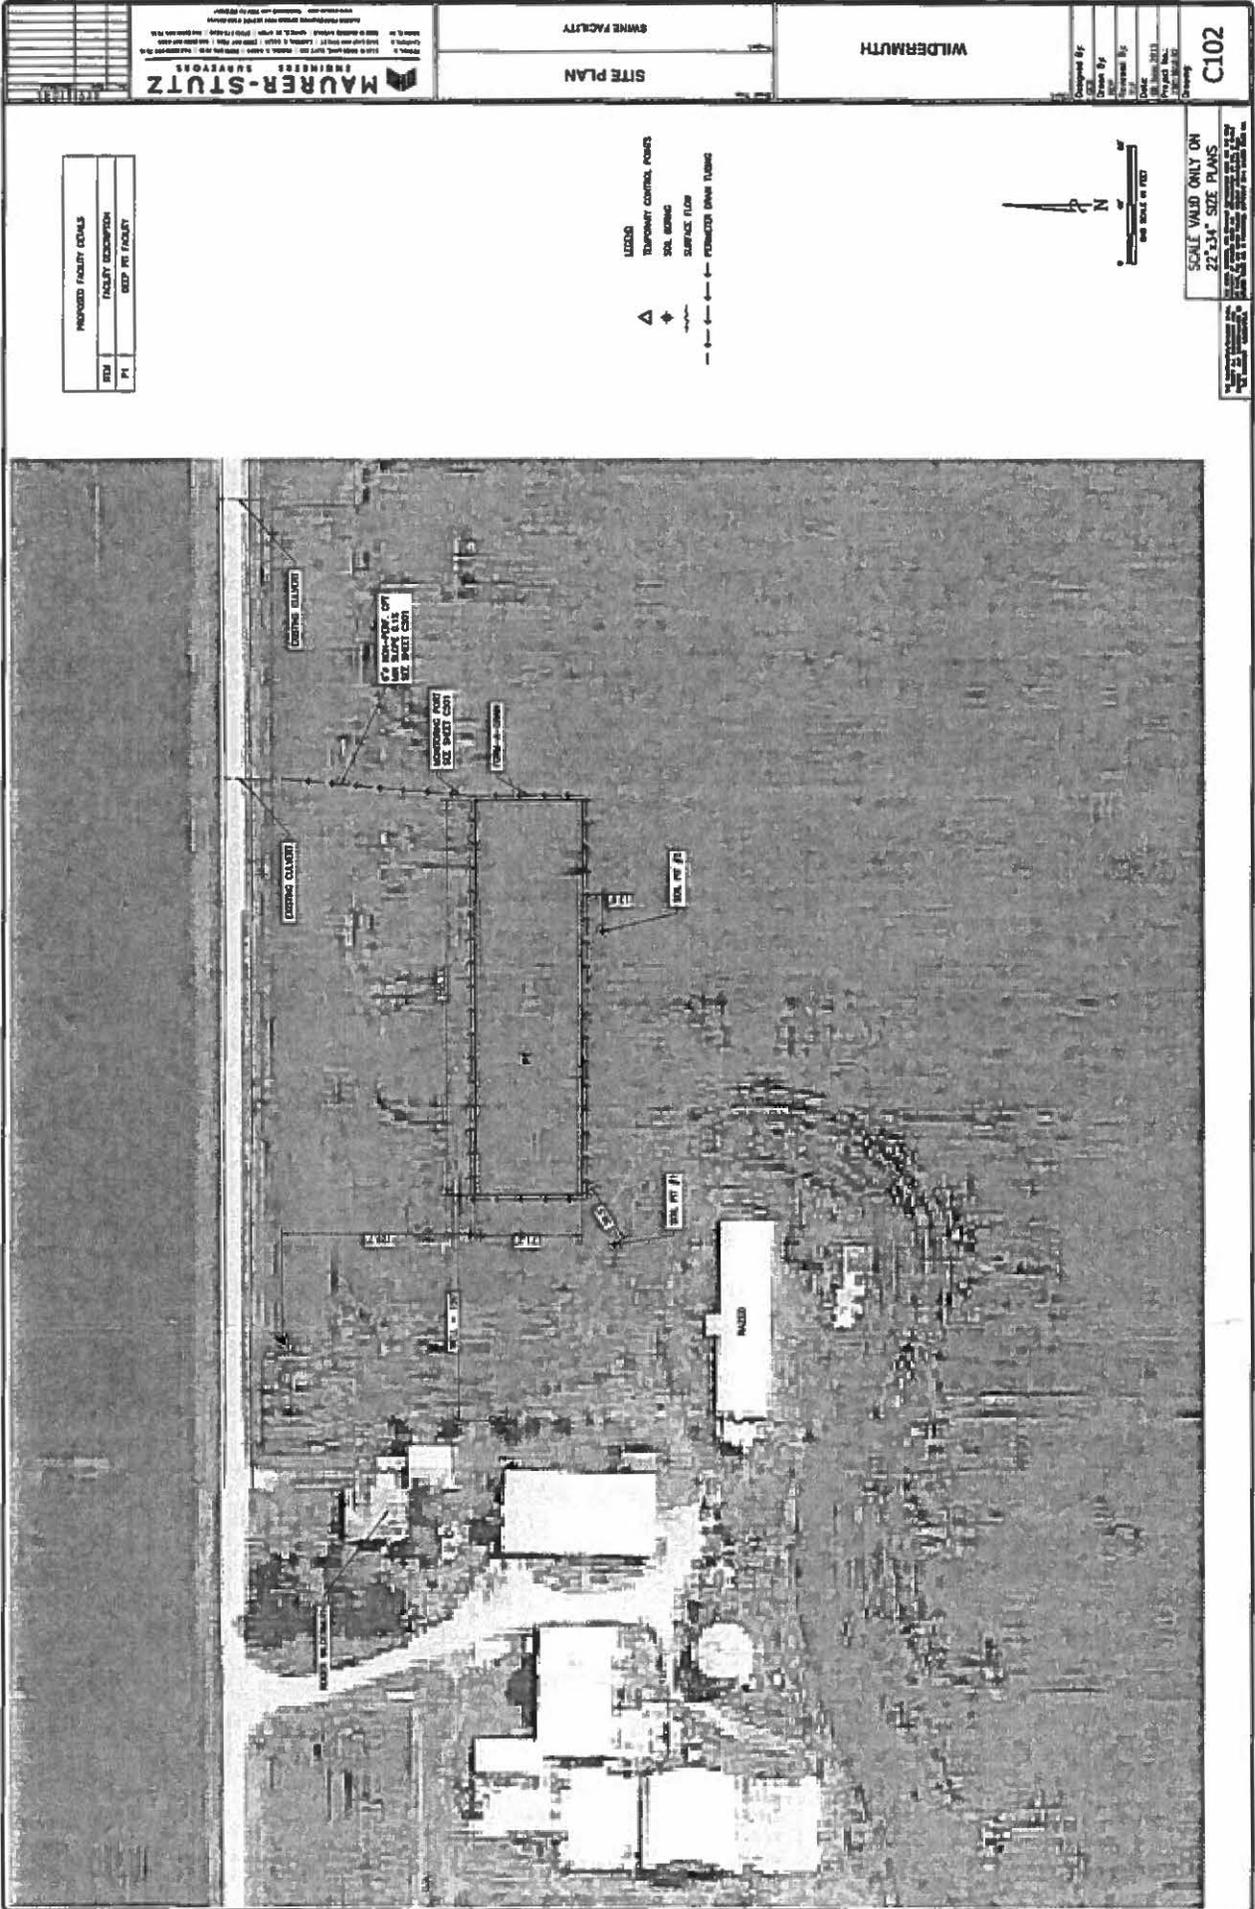

PROPOSED FACILITY DETAILS	
ITEM	FACILITY DESCRIPTION
PI	SWINE FACILITY

MAURER-STUTZ
 ENGINEERS & ARCHITECTS
 1000 N. 10TH ST., SUITE 100
 DENVER, CO 80202
 PHONE: (303) 733-1100
 FAX: (303) 733-1101
 WWW.MAURER-STUTZ.COM

SITE PLAN
 SWINE FACILITY

WILDERMUTH

Designed By: [Blank]
 Drawn By: [Blank]
 Reviewed By: [Blank]
 Date: 08/26/2016
 Project No.: 16-001
 Drawing No.: C102

SCALE VALID ONLY ON
 22"x34" SIZE PLANS
 THIS PLAN IS THE PROPERTY OF MAURER-STUTZ ENGINEERS & ARCHITECTS. IT IS TO BE USED ONLY FOR THE PROJECT AND SITE SPECIFICALLY IDENTIFIED HEREON. IT IS NOT TO BE REPRODUCED OR TRANSMITTED IN ANY FORM OR BY ANY MEANS, ELECTRONIC OR MECHANICAL, INCLUDING PHOTOCOPYING, RECORDING, OR BY ANY INFORMATION STORAGE AND RETRIEVAL SYSTEM, WITHOUT THE WRITTEN PERMISSION OF MAURER-STUTZ ENGINEERS & ARCHITECTS.


MAURER-STUIZ ENGINEERS
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PERMETER DRAIN AND GRADING DETAILS

WILDERMUTH SWINE FACILITY

Drawn By: ...
 Checked By: ...
 Date: ...
 Project No.: ...
 Drawing No.: ...

C501

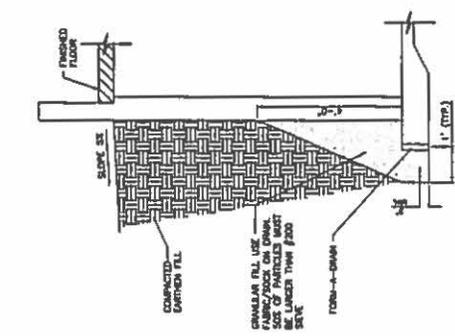

BACKFILL PERIMETER DRAIN SYSTEM DETAIL

- DRAINAGE SYSTEM NOTES:**
1. PERFORATIONS SHALL BE A MINIMUM OF 1/4" DIA.
 2. SLOTTED PERFORATIONS SHALL NOT EXCEED 1/8" WIDTH.
 3. SLOTTED PERFORATIONS SHALL NOT EXCEED 3/16" DIA. EXCEPT WHERE NOTED.
 4. TUBING SHALL HAVE 450D-5-400 (1" - 4") OR 450D-5-407 (1" - 2 1/2") AND AVOID WELLS PERIMETER OF BUILDING.
 5. TUBING SHALL BE PLACED AROUND EXISTING PERIMETER OF BUILDING.
 6. TOP OF TUBING SHALL BE AT OR BELOW TOP OF FRT FLOOR ELEVATION.
 7. TUBING SHALL BE WITHIN 2" OF FOOTING.
 8. JOINTS BETWEEN TUBING SHALL BE MADE WITH 3" WELDS.
 9. THE LAST 10 FEET OF PIPE ON LOWER LEVELS SHALL BE NON-PERFORATED. THE PERFORATIONS SHALL BE CONNECTED TO EXISTING FIELD TUBING. SEE CHGS & D110.

- INSTALLATION NOTES:**
1. PERIMETER DRAINAGE TUBING SHALL BE INSTALLED ACCORDING TO SDCS SECTION 5.11.
 2. PERIMETER DRAINAGE TUBING SHALL BE INSTALLED ACCORDING TO SDCS SECTION 5.11.

GENERAL NOTES:


1. PERMITS AND/OR PROJECT APPROVALS HAVE BEEN OBTAINED FOR THIS PROJECT. THE CONTRACTOR SHALL BE RESPONSIBLE FOR OBTAINING ALL NECESSARY PERMITS AND/OR APPROVALS FOR THE PROJECT.

SUBSURFACE DRAIN TUBING SIZE/LENGTH CHART

TUBING SIZE	MAXIMUM LENGTH
4"	500'
5"	1000'
6"	1500'
8"	3100'
10"	3300'
12"	8100'

NOTE:
 CHECK TO NEXT LARGER PIPE SIZE BEFORE MAXIMUM UPWARD BENDS OF 90 DEGREE.

ITEM	QUANTITY	UNIT
PERIMETER DRAIN TUBING 4" DIA	200	LF
PERIMETER DRAIN TUBING 5" DIA	10	LF
PERIMETER DRAIN TUBING 6" DIA	10	LF
PERIMETER DRAIN TUBING 8" DIA	1	LF
PERIMETER DRAIN TUBING 10" DIA	1	LF
PERIMETER DRAIN TUBING 12" DIA	1	LF

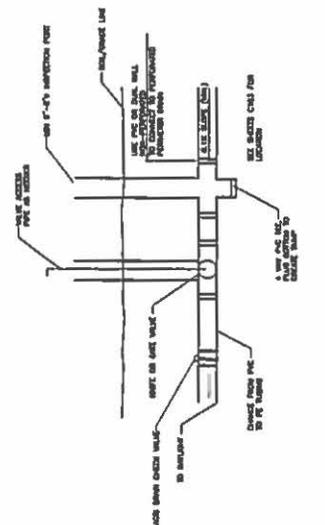

NARROW TRENCH PIPE INSTALLATION DETAIL

1. CONTRACTOR SHALL BE RESPONSIBLE FOR OBTAINING ALL NECESSARY PERMITS AND/OR APPROVALS FOR THE PROJECT.
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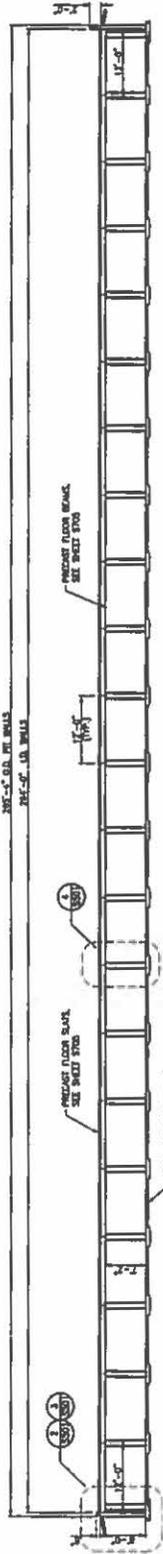


OPEN TRENCH PIPE INSTALLATION DETAIL


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SCALE: VALID ONLY ON 27"x34" SIZE PLANS

	MAURER-STUTZ ENGINEERS LEICHTENSTADT	PIT SECTIONS BONE FACILITY	WILDERMUTH	Drawing No. S301 Date: 08 August 2013 Project:
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(A) PIT LONGITUDINAL SECTION
SCALE 1/4" = 1'-0"



(B) PIT CROSS SECTION
SCALE 1/4" = 1'-0"

SHEET INDEX
 1. SEE SHEET S101 FOR SPACING AND SUGGESTED LOCATIONS OF SLAB CONTROL JOINTS.
 2. ALL GAPS BETWEEN BEAM OR SLAB JOINTS SHALL BE FILLED WITH CONCRETE AND SHALL BE CAST AGAINST THE WALLS.

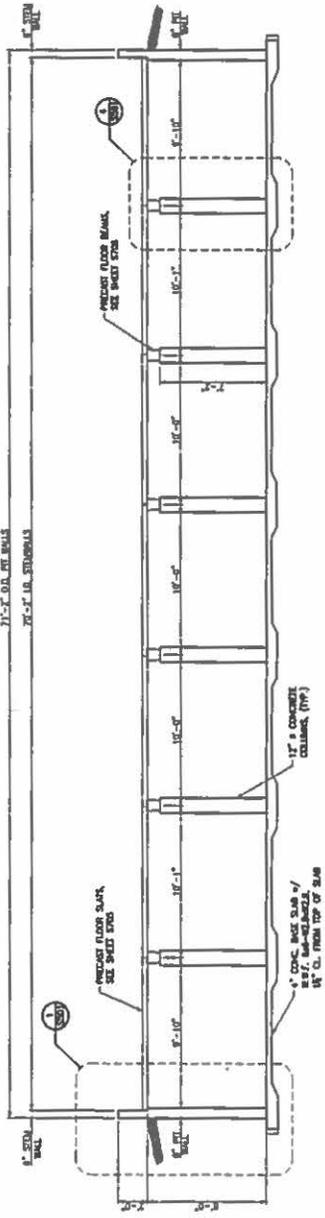SCALE VALID ONLY ON 27' x 34' SIZE PLANS


MAURER-STUTZ ENGINEERS ARCHITECTS
 1000 W. 10th Street, Suite 100, Lincoln, NE 68502
 Phone: (402) 441-1111 Fax: (402) 441-1112
 www.maurer-stutz.com

PRECAST FLOOR MEMBERS
 BIRNIE FACILITY


WILDERMUTH

Drawn By: []
 Check By: []
 Revised By: []
 Date: []
 Project No.: 17-0001
 Drawing No.: **S705**

MANUFACTURER: CUSTOM PRECAST, INC.

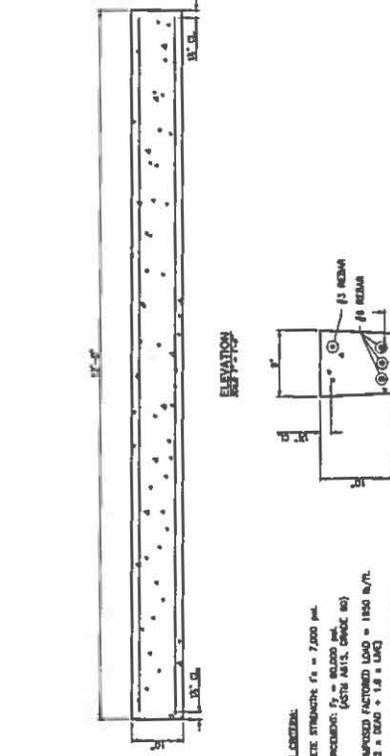

DESIGN CRITERIA:
 CONCRETE STRENGTH: $f_c = 7,000$ psi
 REINFORCEMENT: $f_y = 70,000$ psi
 (ASTM A615, GRADE 60)
 SUPERIMPOSED FACTORED LOAD = 1850 psf
 (1.2 x DEAD + 1.8 x LIVE)
 3" MINIMUM BEARING LENGTH AT EACH END OF BEAM FOR FULL WIDTH OF BEAM. TOTAL BEARING LENGTH AT EACH END SHALL BE GREATER THAN 6".
 ALL CONCRETE AND BEAM DETAILS SHALL CONFORM TO AC 308.
 BEAMS SHORTER THAN 14'-0" MAY BE FABRICATED OR CUT TO LENGTH. BEAMS AT CUT ENDS OF THE BEAM SHALL BE COATED WITH AN EPoxy PAINT.

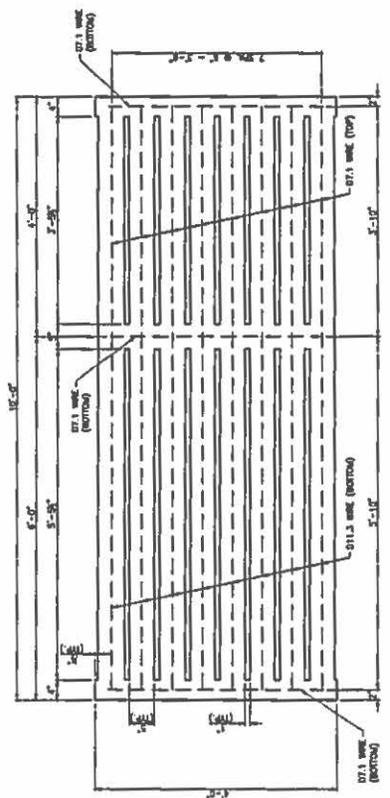

PLAN



LONGITUDINAL SECTION



CROSS SECTION
 10' GANG SLAT
 SIZE 7'-0" x 7'-0"

DESIGN CRITERIA:
 CONCRETE STRENGTH: $f_c = 7,000$ psi
 REINFORCEMENT: $f_y = 70,000$ psi
 (ASTM A615)
 DEAD LOAD: 18.8 psf (CONCRETE FLOOR LOAD)
 12.8 psf (PARTIAL)
 LIVE LOAD: PER ASCE STANDARD CP 318.2
 150 psf (INDIVIDUAL SLAT SPACING)
 75 psf (GANG SLAT FULL SPACING)
 3" MIN BEARING LENGTH AT EACH END FOR FULL WIDTH OF SLAT.
 ALL CONCRETE AND BEAM DETAILS SHALL CONFORM TO AC 308.
 MAX. APPROPRIATE SIZE = 8".
 IF NECESSARY FOR FIT, SLATS MAY BE CUT TO WIDTH (MIN. 1'-4" WIDTH). BEAMS AT CUT ENDS SHALL BE COATED WITH AN EPoxy PAINT.

SCALE VALID ONLY ON 22"x34" SIZE PLANS

MAURER-STUTZ ENGINEERS ARCHITECTS
 1000 W. 10th Street, Suite 100
 Lincoln, NE 68502
 Phone: (402) 441-1111
 Fax: (402) 441-1112
 www.maurer-stutz.com

Point(s) of Waste Water Discharge:

Identify the location of the discharge to the receiving stream. This will typically refer to a source of water pollution but can include water-carried wastes from air pollution control facilities.

Plans and Specifications Attached Yes No

Submit Drawings, which clearly show:

- (a) Point(s) of discharge to receiving stream; and
- (b) Sewers and process piping to and from the control facility.

Are contaminants (or residues) collected by the control facility? Yes No

Note: If the collected contaminants are disposed of other than as wastes, state the disposition of the materials, and the value dollars reclaimed by the sale or reuse of the collected substances. State the cost of reclamation and related expense.

Project Status:

Date Installation Completed: Nov 20, 2015

Provide the date the pollution control facility was first placed into service and operated. If not, explain.

SWINE CONFINEMENT FACILITY WAS PLACED IN SERVICE ON 11/30/15.

Status of installation on date of application:

COMPLETE

III. Verification and Signature:

The following information is submitted in accordance with the Illinois Property Tax Code, as amended, and to the best of my knowledge is true and correct.

Any person who knowingly makes a false, fictitious, or fraudulent material statement, orally or in writing, to the Illinois EPA commits a Class 4 felony. A second or subsequent offense after conviction is a Class 3 felony. (415 ILCS 5/44(h))

Printed Name:

Title:

For incorporated entities, signature should be from an authorized corporate representative.

Signature:

Date:

Faught, Thaddeus

From: Keller, Al
Sent: Friday, December 11, 2015 10:10 AM
To: Faught, Thaddeus
Subject: FW: Application for Certification (Property Tax Treatment) Pollution Control Facility

Thad, can you find this tax cert and include this email with that file. We can use this email for correction of the PIN number.
thanks

From: Emily Baum [<mailto:embaum10@gmail.com>]
Sent: Friday, December 11, 2015 9:23 AM
To: Keller, Al
Cc: mitch@baumfarms.com; tawildermuth@gmail.com
Subject: RE: Application for Certification (Property Tax Treatment) Pollution Control Facility

Hi,

I wanted to follow up with you again, as from the certified mail tracking information, it shows the application was received on Wed. morning, Dec. 9th, in your office. Do you need more information, or can you correct this Property Index Number on the application with the information and attachments sent in the message below?

Thank you again, for your time in reviewing the application.

Sincerely,
Emily Baum

From: Emily Baum [<mailto:embaum10@gmail.com>]
Sent: Tuesday, December 08, 2015 10:43 AM
To: al.keller@illinois.gov
Cc: mitch@baumfarms.com; tawildermuth@gmail.com
Subject: Application for Certification (Property Tax Treatment) Pollution Control Facility

Good morning!

I am writing today on behalf of NextGen Agriculture LLP. An Application for Certification (Property Tax Treatment) Pollution Control Facility was sent via U.S. mail to your attention yesterday from NextGen Agriculture LLP for a new hog confinement in Henry County, IL. The same documents were forwarded to our county assessor via email yesterday. Our assessor brought to our attention that the Property Index Number (PIN) that is stated on the application you will be receiving had been changed, which we were unaware of until today. On the form that was sent, it says the PIN is 12-12-100-002, but the correct PIN is 12-12-100-004.

You will be receiving the signed copy in the mail with the incorrect Property Index Number tomorrow. I have included a corrected copy with the correct PIN in this message.

Please advise if this is sufficient information to correct the application or if you need more information from us.

Thank you for your time.

Sincerely,

Emily Baum
NextGen Agriculture LLP

STATE OF ILLINOIS

COUNTY OF SANGAMON

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CERTIFICATE OF SERVICE

I, the undersigned attorney at law, hereby certify that I have served on the date of September 27, 2016, the attached **APPEARANCE** and **RECOMMENDATION OF THE ILLINOIS ENVIRONMENTAL PROTECTION AGENCY**, upon the following persons by First Class U.S. Mail, with proper postage or delivery charges prepaid:

Steve Santarelli
Illinois Department of Revenue
101 West Jefferson
P.O. Box 19033
Springfield, Illinois 62794

Taylor Wildermuth
13126 US HWY 6
Geneseo, Illinois 61274

[Electronic Filing]

Clerk
Illinois Pollution Control Board
James R. Thompson Center
100 West Randolph Street, Suite. 11-500
Chicago, Illinois 60601

ILLINOIS ENVIRONMENTAL PROTECTION AGENCY

/s/ Vera Herst
Assistant Counsel
Division of Legal Counsel
1021 North Grand Avenue East
P.O. Box 19276
Springfield, Illinois 62794-9276
217.782.5544
217.782.9143 (TDD)

THIS FILING IS SUBMITTED ON RECYCLED PAPER